ERP MODIFICATION PLANS

HOLIDAY INN EXPRESS

13201 OVERSEAS HIGHWAY MARATHON, MONROE COUNTY, FLORIDA

PROJECT LOCATION -

VICINITY MAP

SCOPE OF PROJECT

THE PROPOSED PROJECT CONSISTS OF THE EXPANSION OF THE EXISTING HOLIDAY INN EXPRESS HOTEL, INCLUDING NEW BUILDINGS, ROADWAYS, SIDEWALKS, PARKING AREAS, AND A STORMWATER MANAGEMENT SYSTEM.

SITE INFORMATION

Key West, Florida 33040 AUTHORIZATION #2940 ph:305-293-3263 fax:293-4899

RICHARD J. MILELL

EXPANSION

Checked By RJM

Scale: AS NOTEI

AutoCad File No.

COVER

Date: JUNE 1, 2015

RE# 100260.0001 & 100260.000102

(3)

3 SAMPLE DETAIL

3 SAMPLE DETAIL

SAMPLE TYPICAL DETAIL

* SCALE: 1/4" = 1'-0'

* C-1, C-2

ADDRESS: 13201 OVERSEAS HIGHWAY

MARATHON, FL 33050

SECTION/RANGE/TOWNSHIP: 05/66S/33E

SYMBOL LEGEND **GENERAL** EXPRESS DETAIL OR SECTION DESIGNATION (NUMBERS TO BE USED FOR DETAILS/ELEVATIONS AND LETTERS FOR SECTIONS) HOLIDAY INN SHEET NUMBER ON WHICH DETAIL SECTION/ELEVATION IS DRAWN SECTION ELEVATION DETAIL/SECTION/ **ELEVATION REFERENCE** SYMBOL **DESCRIPTION**

PREVENT THE TRANSPORTATION OF SEDIMENT DOWNSTREAM INTO STREETS, STORM THE CONTRACTOR SHALL ADJUST (AS REQUIRED) PIPELINE ALIGNMENTS HORIZONTALLY AND/OR VERTICALLY TO AVOID CONFLICTS WITH ACTUAL FIELD CONDITIONS AS UNCOVERED DURING CONSTRUCTION. FIELD ADJUSTMENT SHALL BE COORDINATED WITH, AND APPROVED BY THE ENGINEER. THE CONTRACTOR SHALL PROVIDE ALL DEWATERING EQUIPMENT NECESSARY TO KEEP

- EXCAVATIONS DRY AND SHALL PROVIDE ALL SHORING, SHEETING, AND BRACING NECESSARY TO PROTECT WORKMEN, ADJACENT STRUCTURES, UTILITIES, EXISTING PAVEMENT, OR TO MINIMIZE TRENCH WIDTH, AT THE CONTRACTORS EXPENSE.
- THE CONTRACTOR SHALL NOTIFY THE ENGINEER IMMEDIATELY IF THE FIELD CONDITIONS CONFLICT WITH THE PLANS.

INDEX OF DRAWINGS

C-3.1 PROPOSED DRAINAGE PLAN (CONT'D) C-3.2 PROPOSED DRAINAGE PLAN (CONT'D) C-4.0 DRAINAGE DETAILS & SECTIONS

C-4.1 DRAINAGE DETAILS & SECTIONS (CONT'D) C-4.2 DRAINAGE DETAILS & SECTIONS (CONT'D) C-4.3 DRAINAGE DETAILS & SECTIONS (CONT'D) C-4.4 DRAINAGE DETAILS & SECTIONS (CONT'D)

ALL FIELD LAYOUT AND SURVEYING FOR CONSTRUCTION OF THIS PROJECT SHALL BE

PROVIDED BY THE CONTRACTOR AT HIS EXPENSE, CONTRACTOR SHALL PROVIDE THE

APPROXIMATE LOCATIONS. THE CONTRACTOR SHALL NOTIFY THE RESPECTIVE UTILITY

COMPANIES NO LATER THAN 48 HOURS PRIOR TO COMMENCING WORK IN A SPECIFIC

THE CONTRACTOR SHALL COORDINATE THEIR WORK WITH THE OWNER TO MINIMIZE SEWER DISRUPTION. ACCESS TO PROPERTY SHALL BE MAINTAINED AT ALL TIMES.

IT SHALL BE THE RESPONSIBILITY OF THE CONTRACTOR TO SHAPE THE PAVEMENT AT

PROPERTY MARKERS SHALL BE PROTECTED BY THE CONTRACTOR. THE CONTRACTORS

INTERSECTIONS, STREETS, AND DRIVEWAYS SO THAT POSITIVE DRAINAGE WILL BE MAINTAINED WITH NO PONDING OF WATER AS A RESULT OF THE NEW CONSTRUCTION.

REGISTERED SURVEYOR SHALL REPLACE ANY MARKERS THAT ARE DISTURBED. THE CONTRACTOR SHALL PROVIDE AND IMPLEMENT SITE SPECIFIC EROSION AND

SEDIMENT CONTROL PROCEDURES SUCH AS HAY BALES. STAKED SILT BARRIERS. FLOATING TURBIDITY BARRIER, OR OTHER APPROVED METHODS AS REQUIRED TO

AREA. THE CONTRACTOR SHALL BE RESPONSIBLE FOR THE VERIFICATION OF ALL

UTILITY LOCATIONS WITHIN THE WORK AREA. NEITHER THE ENGINEER OR

OWNER/DEVELOPER SHALL BE RESPONSIBLE FOR THESE ITEMS.

EXISTING SUBSURFACE UTILITY HORIZONTAL ALIGNMENTS WERE ESTABLISHED THROUGH THE USE OF AVAILABLE RECORDS AND THEREFORE, ARE SHOWN IN THERE

C-1.0 EXISTING CONDITIONS PLAN

C-3.0 PROPOSED DRAINAGE PLAN

C-5.0 EROSION CONTROL PLAN C-5.1 EROSION CONTROL DETAILS


ENGINEER RECORD DRAWINGS (REDLINES).


C-2.0 PROPOSED WETLAND IMPACTS


G-1.0 COVER SHEET

GENERAL NOTES:

- ALL AREAS AFFECTED BY THIS WORK SHALL BE RESTORED TO A CONDITION EQUAL TO OR BETTER THAN EXISTING CONDITION, UNLESS SPECIFICALLY EXEMPTED BY THE PLANS. THE COST FOR SUCH RESTORATION SHALL BE INCIDENTAL TO OTHER CONSTRUCTION AND NO ADDITIONAL COMPENSATION SHALL BE ALLOWED.
- 11. ALL TRAFFIC CONTROL DEVICES, EQUIPMENT AND INSTALLATION SHALL MEET THE REQUIREMENTS OF THE LOCAL JURISDICTION AND/OR FLORIDA DEPARTMENT OF TRANSPORTATION
- ALL PIPE LENGTHS ARE PLUS OR MINUS. PIPE MEASUREMENTS ARE TO CENTER OF STRUCTURES OR FITTINGS.
- ALL NECESSARY FILL AND EMBANKMENT THAT IS PLACED DURING CONSTRUCTION SHALL CONSIST OF MATERIAL SPECIFIED BY THE SOIL TESTING COMPANY OR ENGINEER AND BE PLACED AND COMPACTED ACCORDING TO THESE PLANS OR THE REFERENCED SOIL REPORTS.
- REQUIREMENTS OF THE SOUTH FLORIDA WATER MANAGEMENT DISTRICT (SFWMD), MONROE COUNTY, AND THE CITY OF MARATHON REGULATIONS SHALL GOVERN ALL
- CONTRACTOR IS RESPONSIBLE FOR OBTAINING ALL PERMITS PRIOR TO STARTING THE

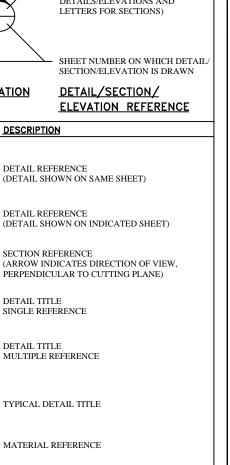

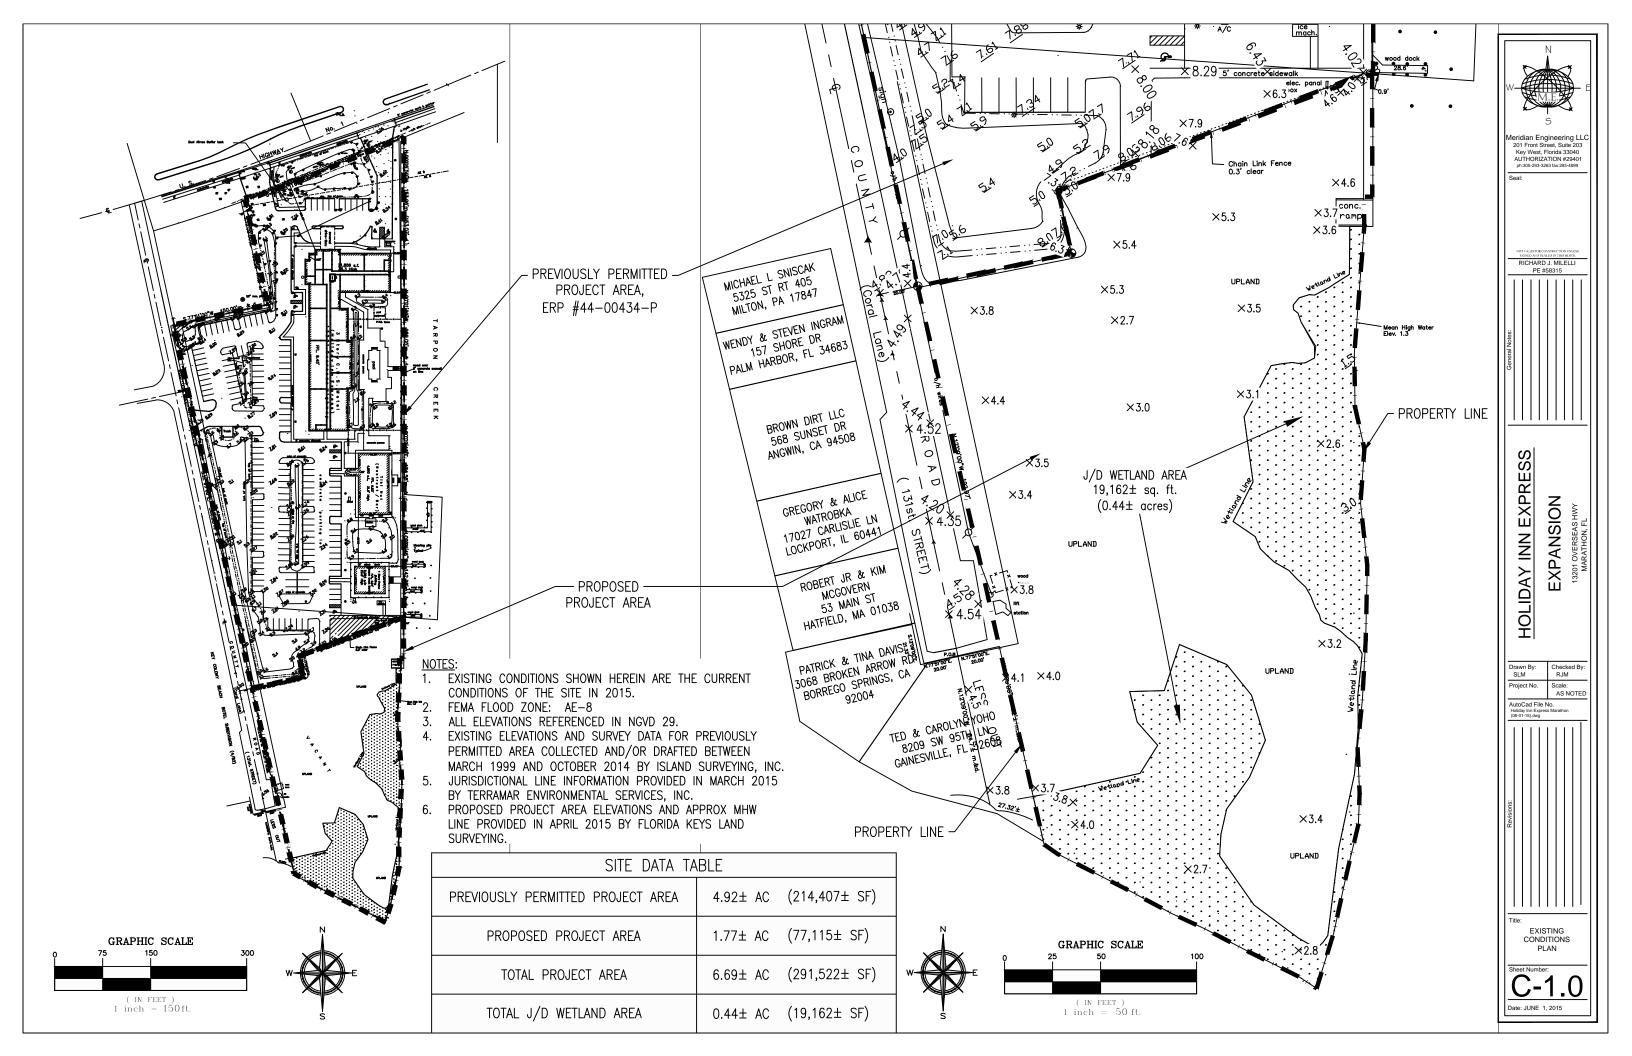

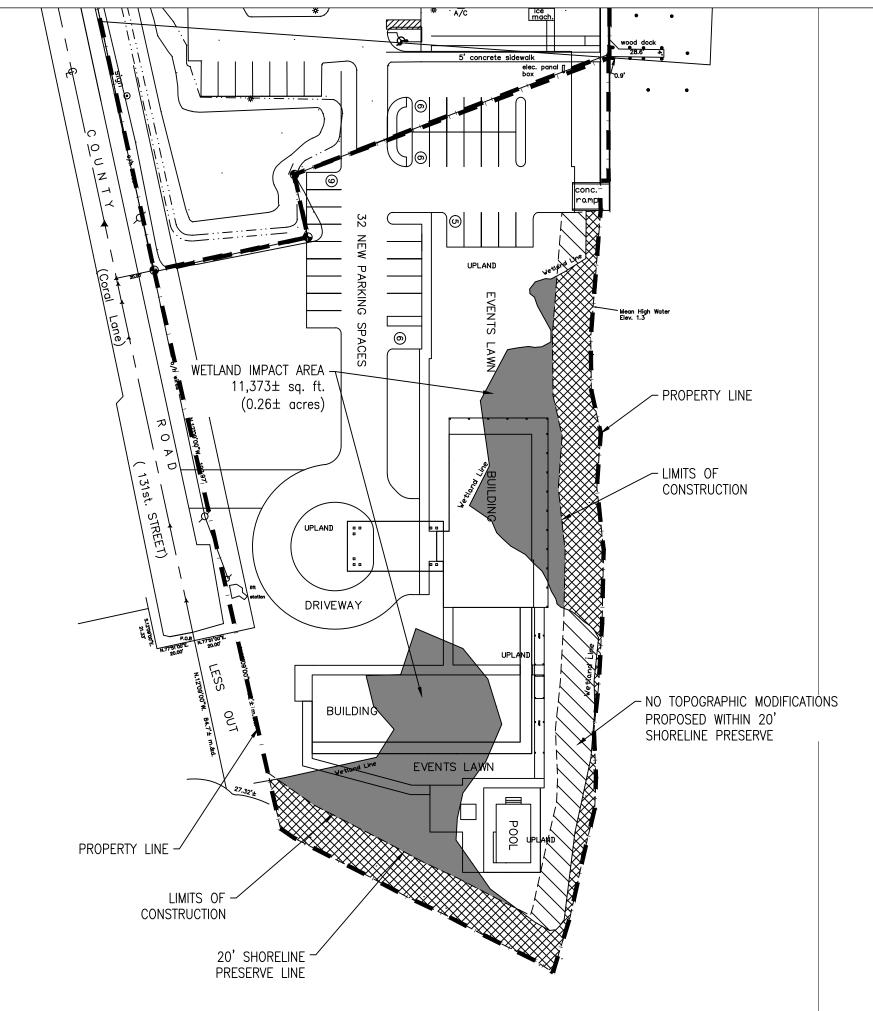


SITE DATA TABLE			
PREVIOUSLY PERMITTED PROJECT AREA	4.92± AC	(214,407± SF)	
NEW PROJECT AREA	1.77± AC	(77,115± SF)	
TOTAL PROJECT AREA	6.69± AC	(291,522± SF)	
TOTAL J/D WETLAND AREA	0.44± AC	(19,162± SF)	
PROPOSED WETLAND IMPACTS	0.26± AC	(11,373± SF)	
UPLANDS WITHIN 20' SHORELINE PRESERVE	0.07± AC	(3,058± SF)	
WETLANDS WITHIN 20' SHORELINE PRESERVE	0.18± AC	(7,792± SF)	
TOTAL AREA OF 20' SHORELINE PRESERVE	0.25± AC	(10,850± SF)	
ESTIMATED QUANTITY OF FILL	11,000 CY		

LEGEND			
	WETLAND IMPACT AREA		
	WETLAND WITHIN SHORELINE PRESERVE AREA		
	UPLANDS WITHIN SHORELINE PRESERVE AREA		
	PROJECT BOUNDARY		
	SHORELINE WETLAND PRESERVE BOUNDARY		

NOTES

- 1. FEMA FLOOD ZONE: AE-8
- 2. ALL ELEVATIONS REFERENCED IN NGVD 29.
- 3. EXISTING ELEVATIONS AND SURVEY DATA FOR PREVIOUSLY PERMITTED AREA COLLECTED AND/OR DRAFTED BETWEEN MARCH 1999 AND OCTOBER 2014 BY ISLAND SURVEYING, INC.
- 4. JURISDICTIONAL LINE INFORMATION PROVIDED IN MARCH 2015 BY TERRAMAR ENVIRONMENTAL SERVICES, INC.
- 5. PROPOSED PROJECT AREA ELEVATIONS AND APPROX MHW LINE PROVIDED IN APRIL 2015 BY FLORIDA KEYS LAND SURVEYING.

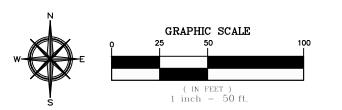




HOLIDAY INN EXPRESS
EXPANSION


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PROPOSED WETLAND IMPACTS

Sheet Number:
C-2.C

Date: JUNE 1, 2015



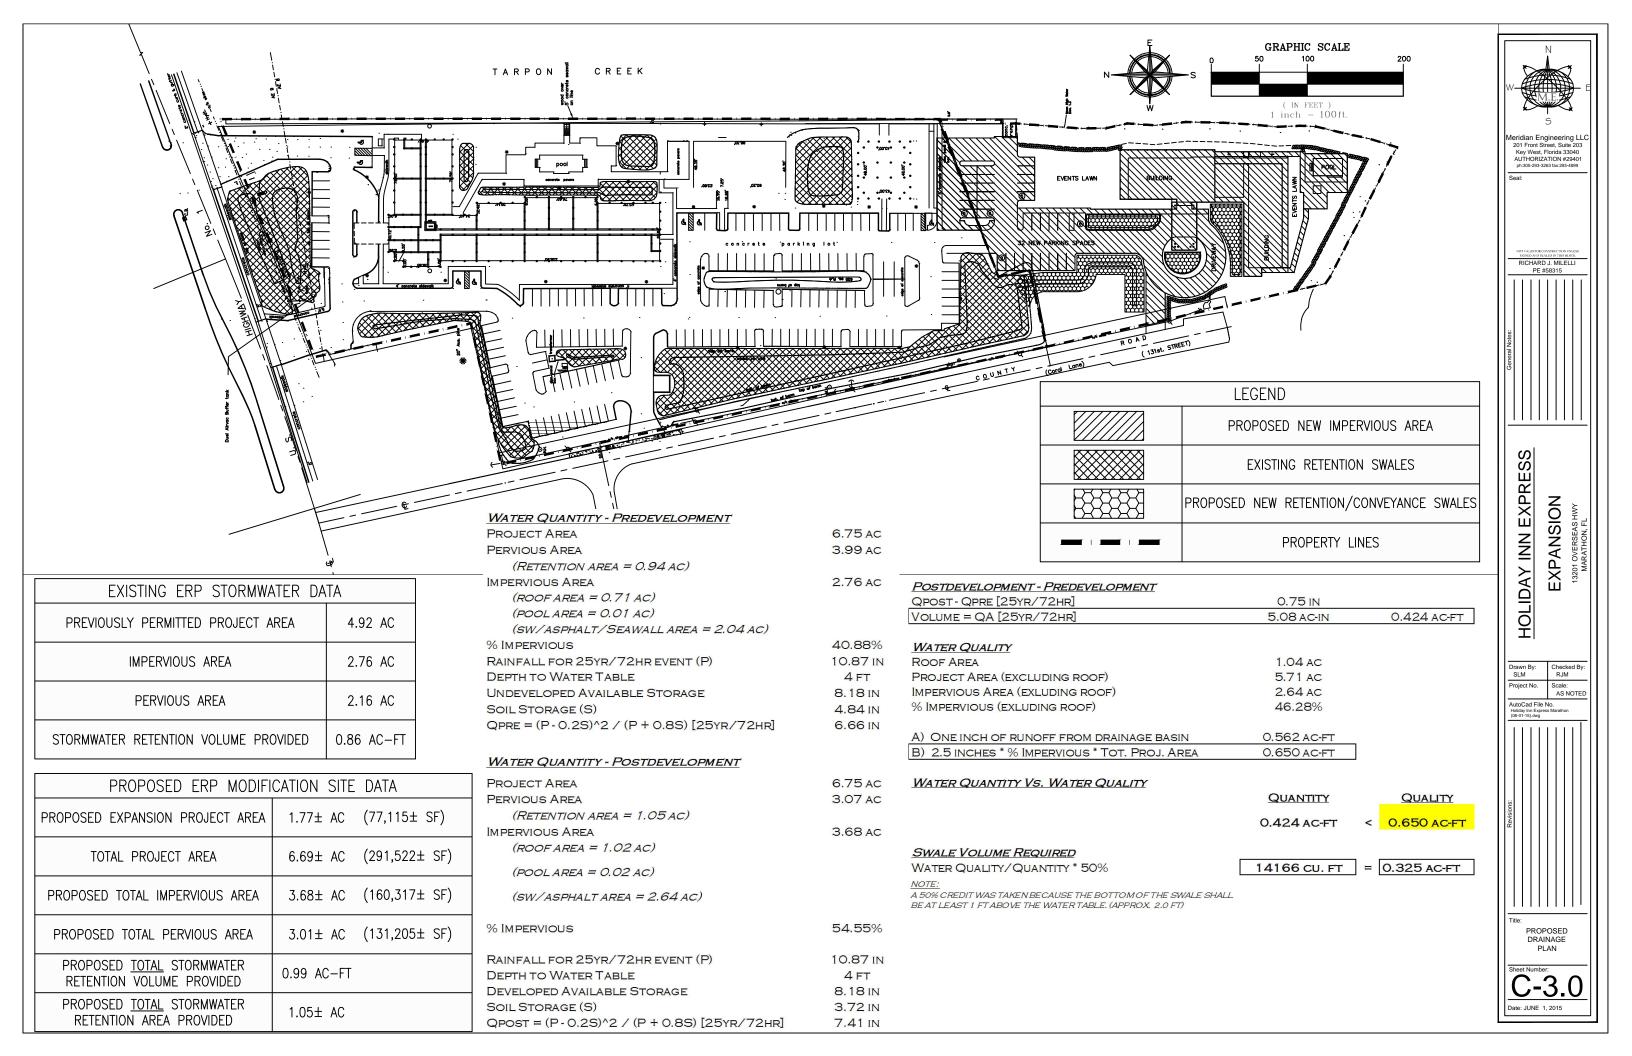

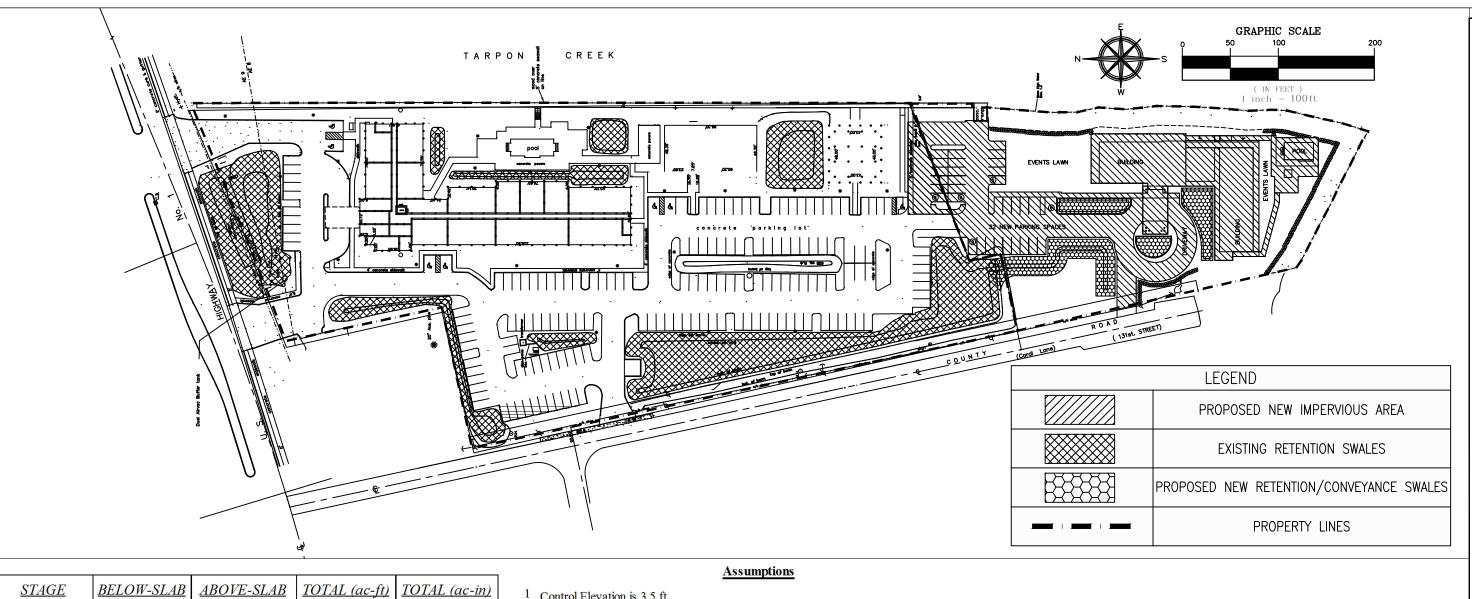Assum	ntions
Assum	DUIOIIS

1 Conf	rol Elev	ation	ic 3	5	ft

ABOVE-SLAB

2.85 ac-ft

5.71 ac-ft

8.56 ac-ft

11.41 ac-ft

STAGE 3.5 ft

4.0 ft

4.5 ft

5.0 ft

5.5 ft

6.0 ft

6.5 ft

7.0 ft

7.5 ft

8.0 ft

8.5 ft

9.0 ft

9.5 ft

10.0 ft

10.5 ft

11.0 ft

0.95 ac-ft

2.14 ac-ft

3.80 ac-ft

5.94 ac-ft

8.56 ac-ft

11.65 ac-ft

15.22 ac-ft

19.26 ac-ft

23.78 ac-ft

28.77 ac-ft

34.24 ac-ft

40.19 ac-ft

46.61 ac-ft

TOTAL (ac-ft) TOTAL (ac-in)

11.41 ac-in

25.68 ac-in

45.66 ac-in

71.34 ac-in

102.73 ac-in

139.83 ac-in

182.63 ac-in

231.14 ac-in

285.36 ac-in

379.53 ac-in

479.40 ac-in

584.98 ac-in

696.27 ac-in

0.95 ac-ft

2.14 ac-ft

3.80 ac-ft

5.94 ac-ft

8.56 ac-ft

11.65 ac-ft

15.22 ac-ft

19.26 ac-ft

23.78 ac-ft

31.63 ac-ft

39.95 ac-ft

48.75 ac-ft

58.02 ac-ft

- 2 Site storage is linear, starting at lowest swale bottom elevation of 5.0 ft. up to slab elevation.
- 3 Site storage above slab is vertical over entire project area.
- Area of developed site grading = Project Area Roof/Water Area

= 6.75 ac - 1.04 ac

= 5.71 ac

Schematic Diagrams


	Above - Slab	Below - Slab
13'		
12'		
11'		
10'		
9'		
8'	5.71 ac	
7'		4 ft
6'		
5'		
4'		5.71 ac

100yr/72hr Runoff Volume = 69.83 ac-in

Min. Building Floor Elevation = 6.48 ft (interpolated) FEMA Flood Elevation Requirement = 8.00 ft

Proposed Min. Building Floor Elevation = 9.00 ft



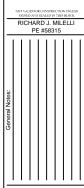


HOLIDAY INN EXPRESS **EXPANSION**

Checked By RJM AutoCad File No. Holiday Inn Express Mar (06-01-15).dwg



PROPOSED DRAINAGE PLAN (CONT'D)

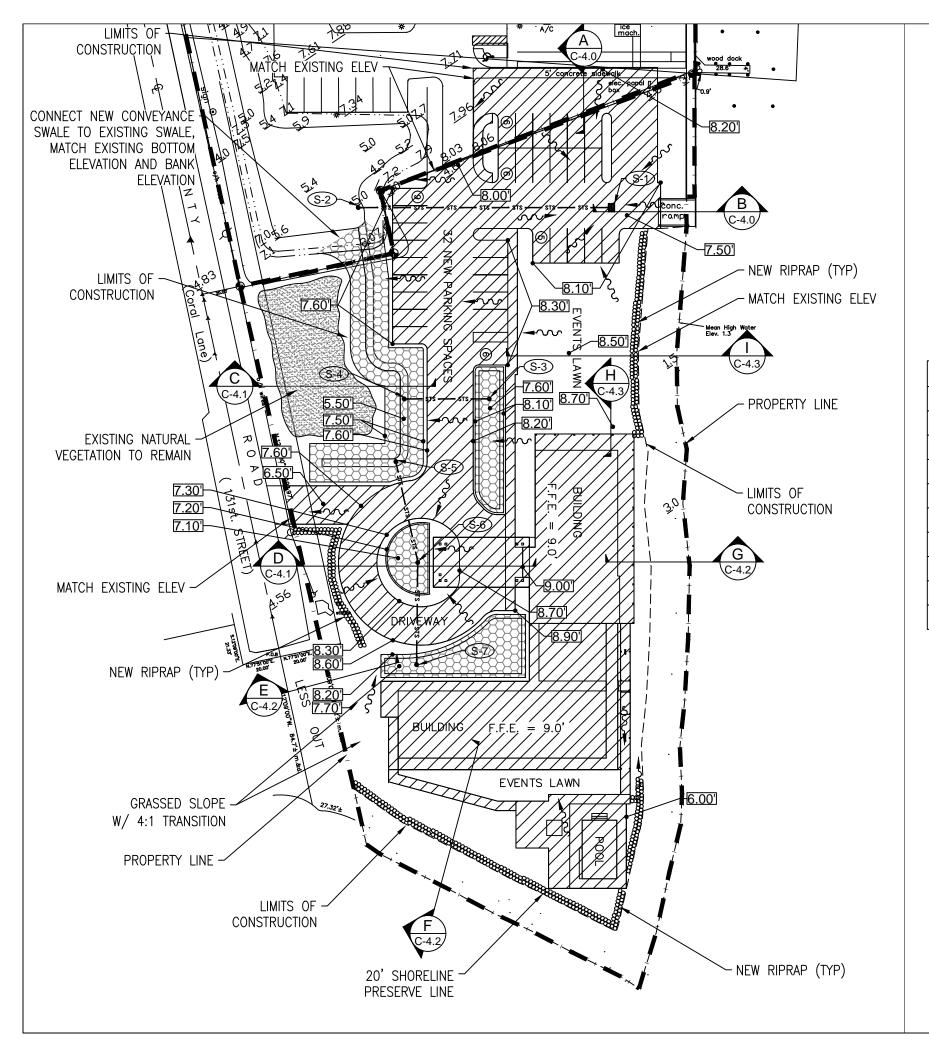

LEGEND		
	PROPOSED NEW IMPERVIOUS AREA	
	PROPOSED NEW RETENTION/CONVEYANCE SWALES	


STORMWATER RETENTION DATA			
STORMWATER RETENTION VOLUME REQUIRED	0.325 AC-FT (14,167 CF)		
STORMWATER RETENTION VOLUME PROVIDED	0.99± AC-FT (42,989± CF)		
STORMWATER RETENTION AREA	1.05± AC		


DRAINAGE PIPE & STRUCTURE DATA					
STRUCT I.D.	<u>PIPE SIZE</u>	PIPE LENGTH	RIM ELEV	PIPE INVERTS (±)	
S-1	15"	4 5 "	129± LF	7.40'±	4.03'
S-2		1291 LF	5.00'±	2.63'	
S-3	15"	42± LF	7.60'±	4.23'	
S-4		<u> 42⊥ L</u> r	5.50"±	3.13'	
S-5			5.50'±	3.13'	
>>>>	15"	52± LF			
S-6			7.10 ' ±	3.68' N / 3.73' S	
>>>>	15"	51± LF			
S-7			7.70'±	4.33'	

NOTE: ALL STORMWATER PIPE SHALL BE ADS N-12? ST IB HDPE PIPE.

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RICHARD J. MILELLI
PE #58315

HOLIDAY INN EXPRESS
EXPANSION

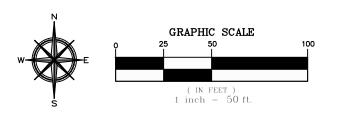 Drawn By:
 Checked By:

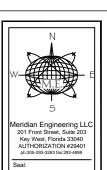 SLM
 RJM

 Project No.
 Scale:

 As NOTED

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 Holiday in Express Marathon (66-01-15),dwg


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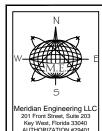
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PROPOSED
DRAINAGE
PLAN (CONT'D)

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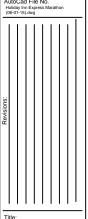
Date: JUNE 1, 2015





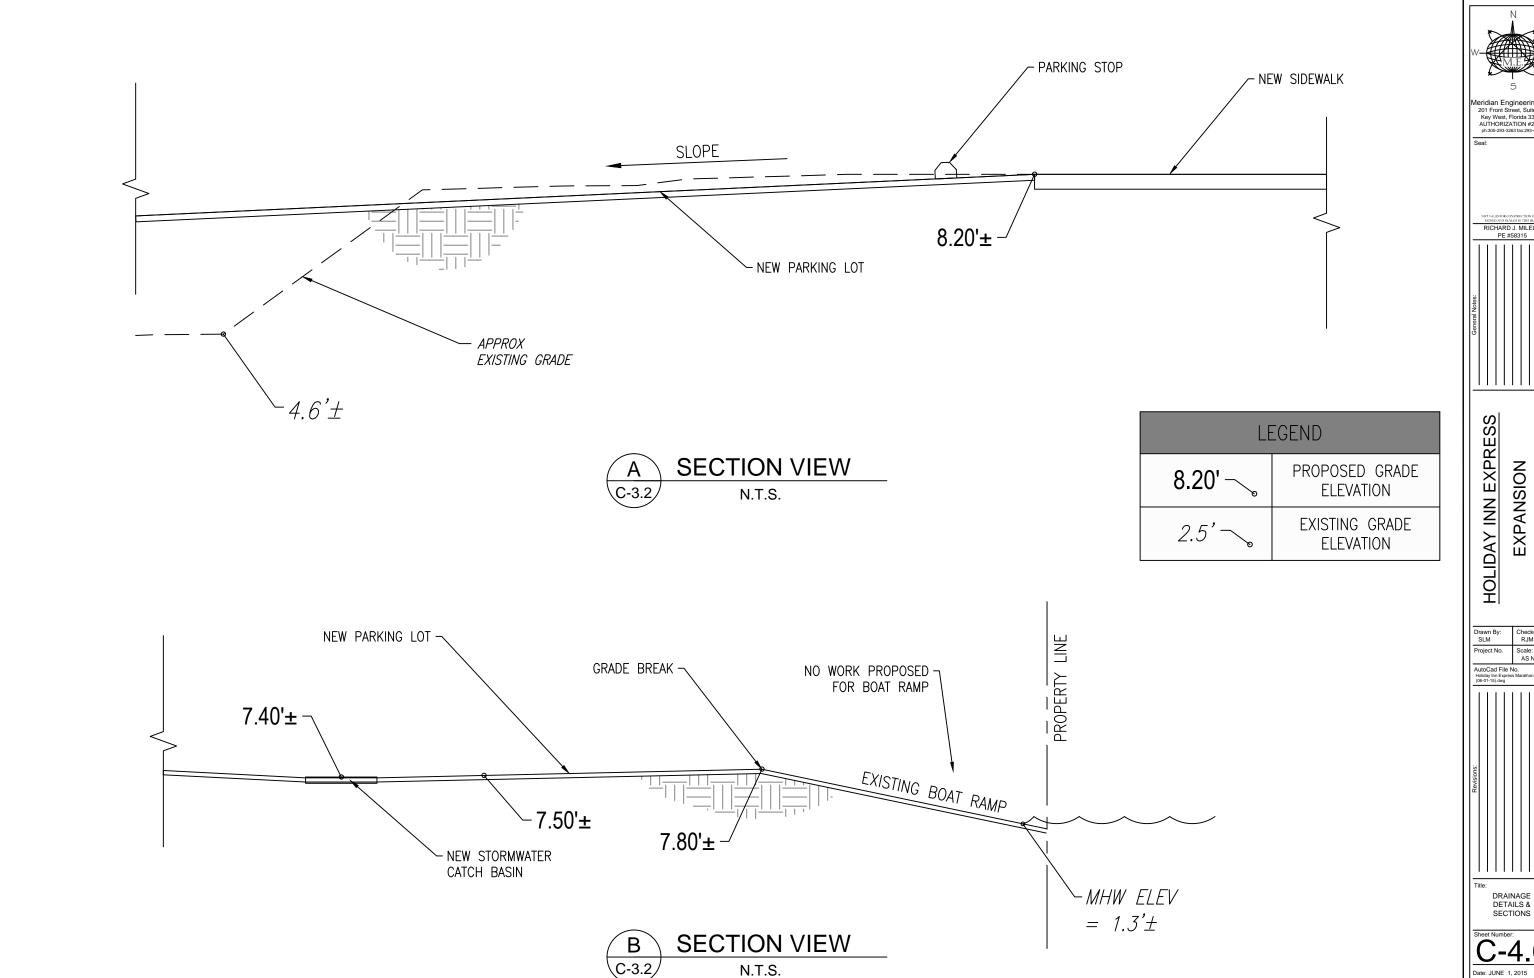

Drawn By: Checked By: RJM
Project No. Scale: AS NOTED





DRAINAGE DETAILS & SECTIONS


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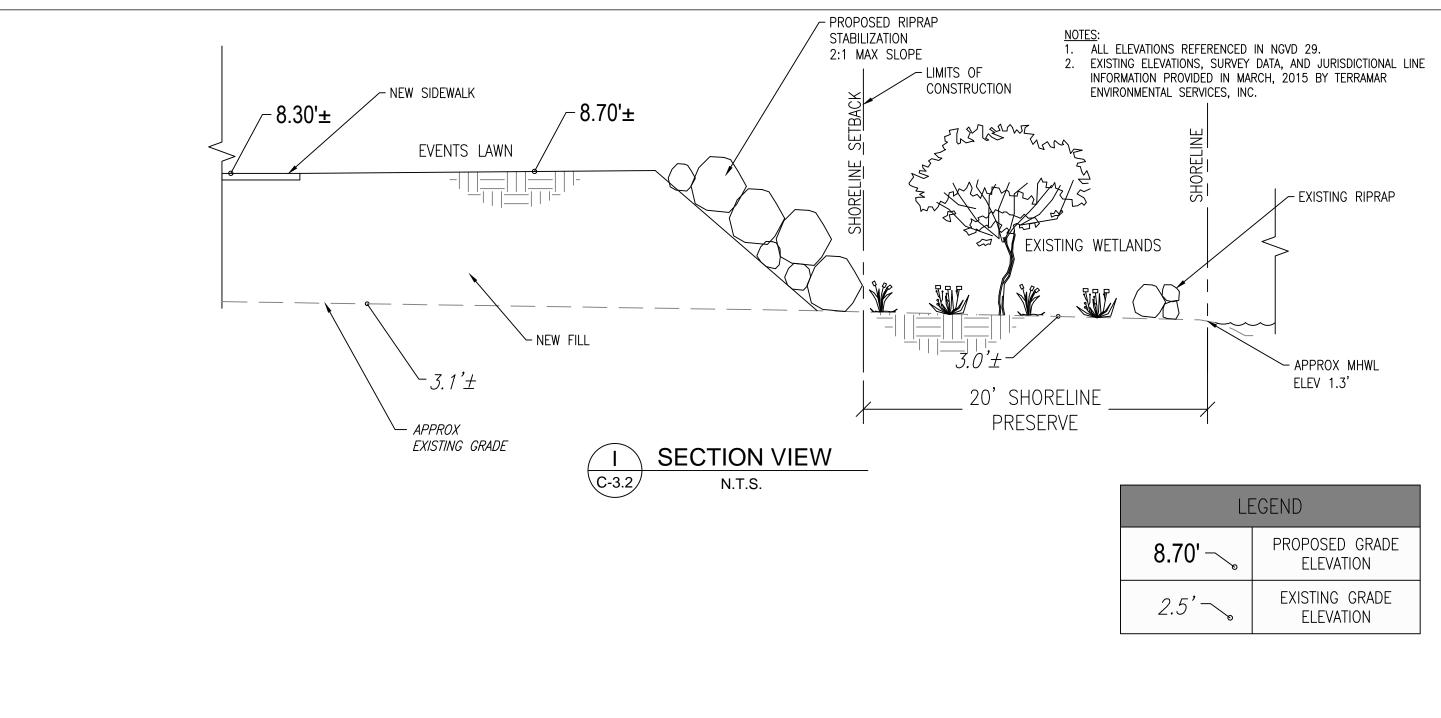
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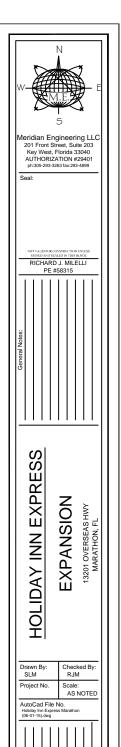
Date: JUNE 1, 2015





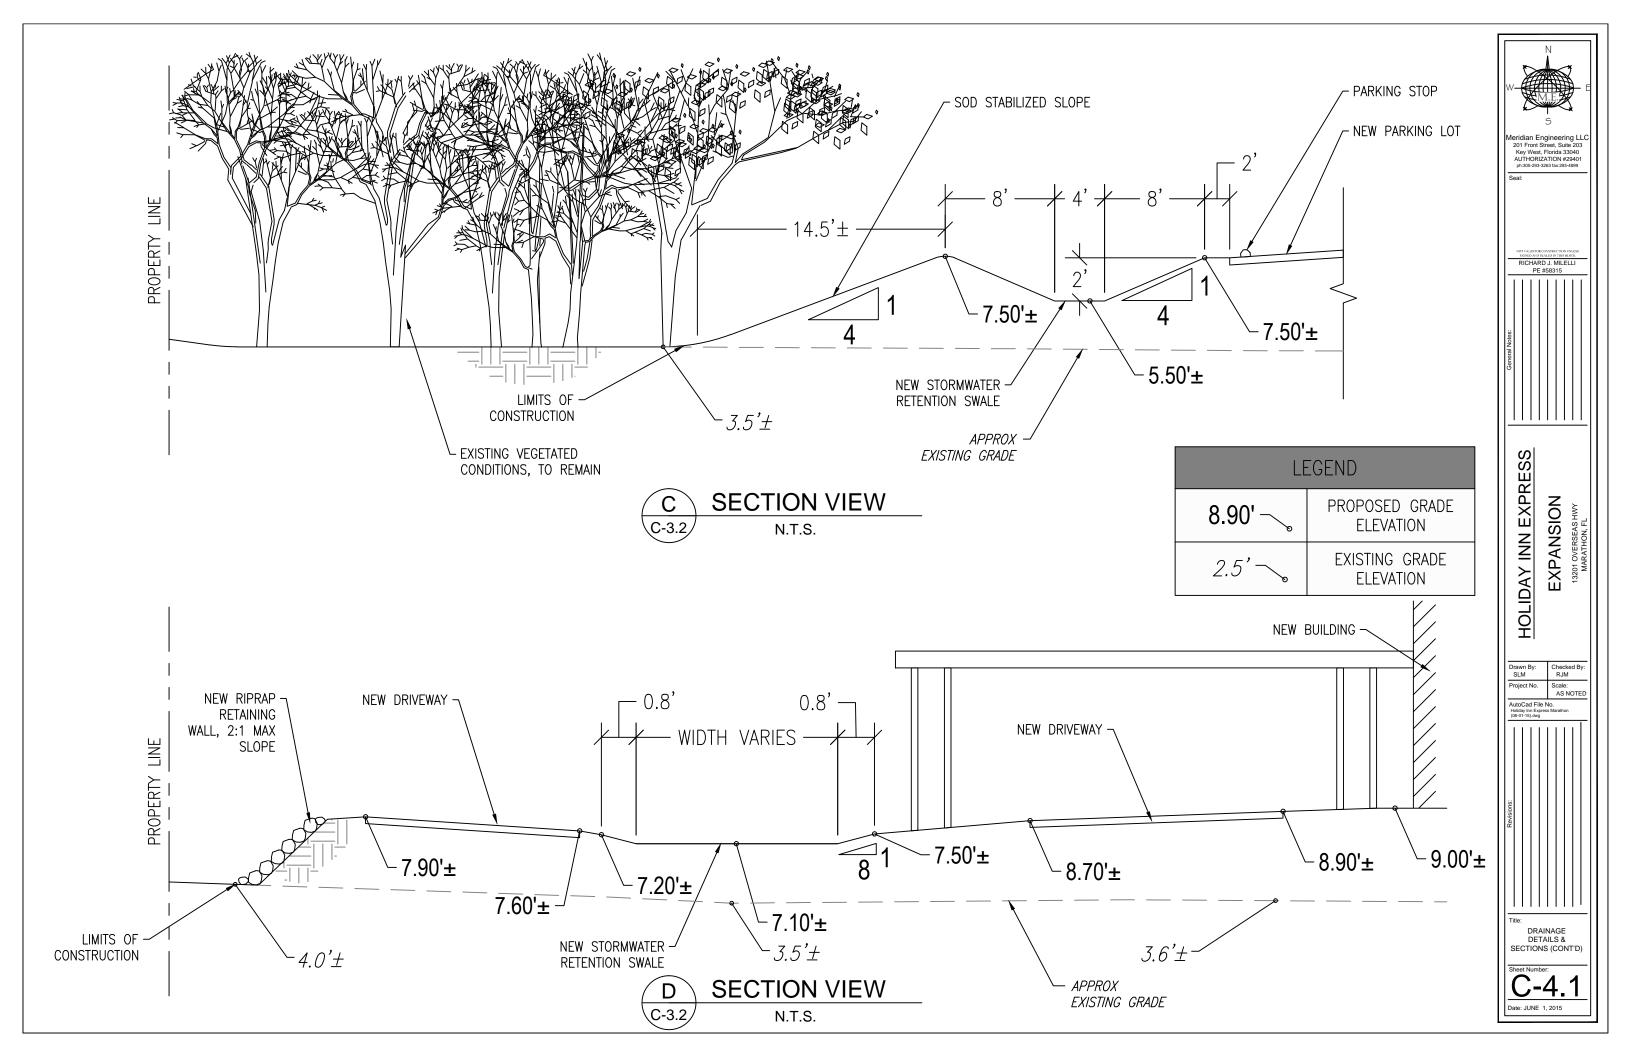

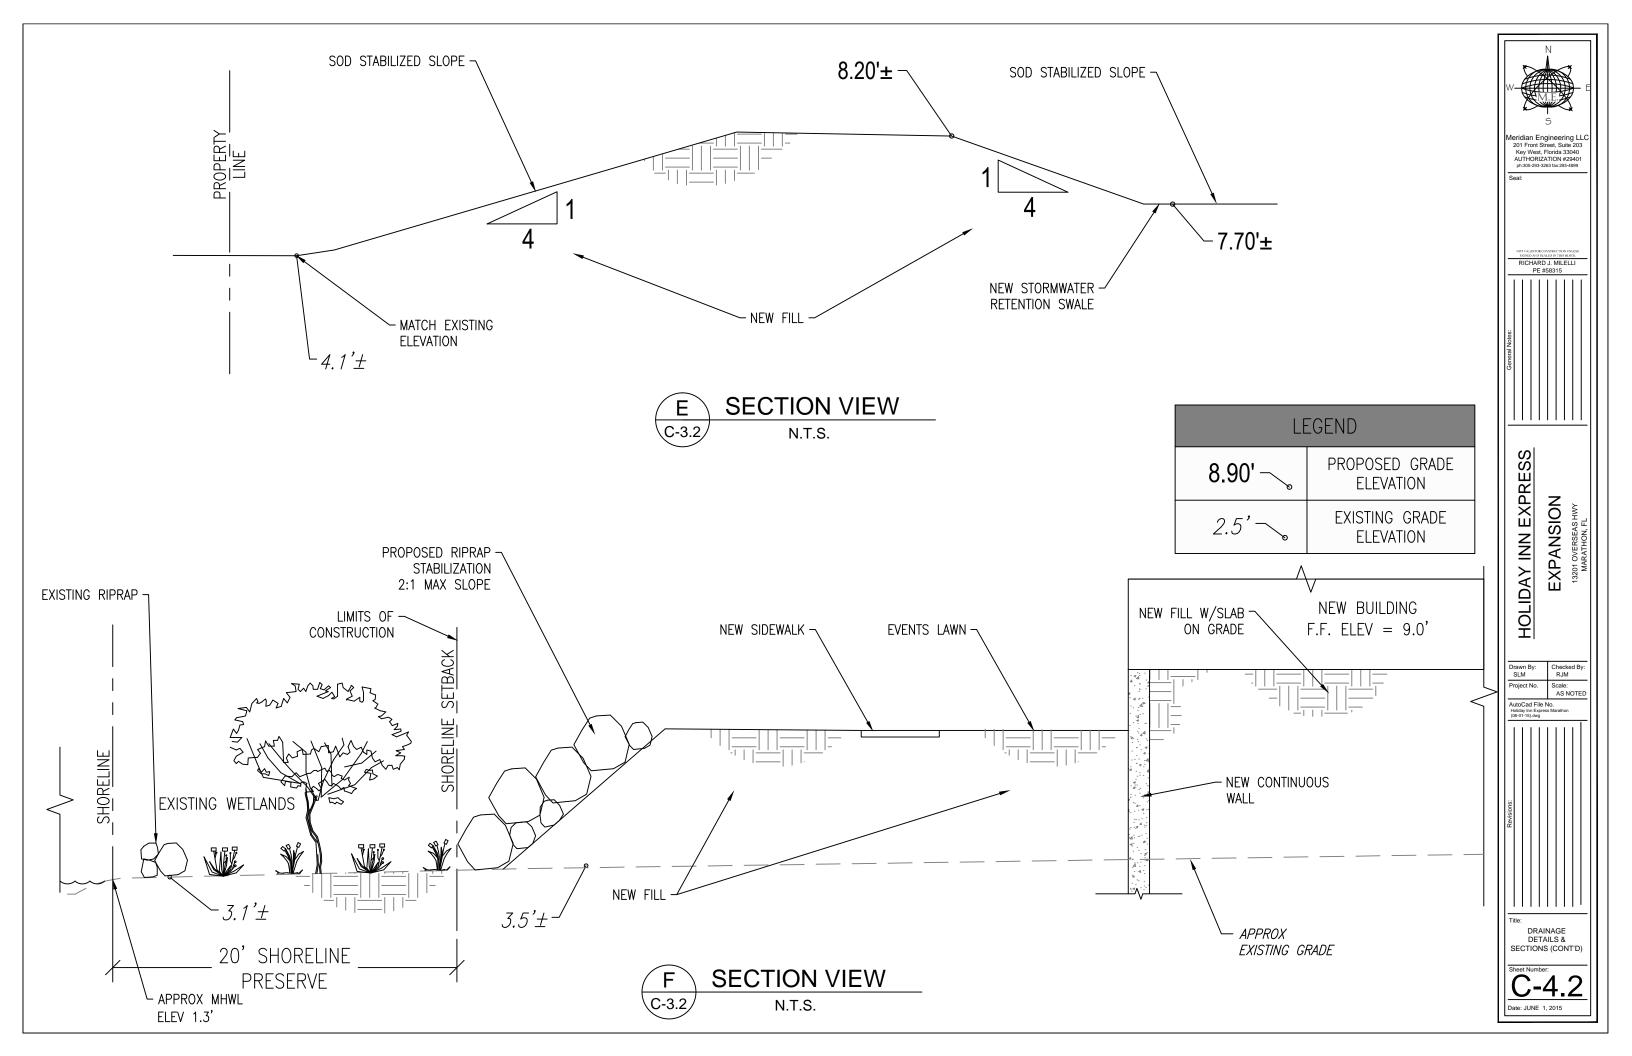


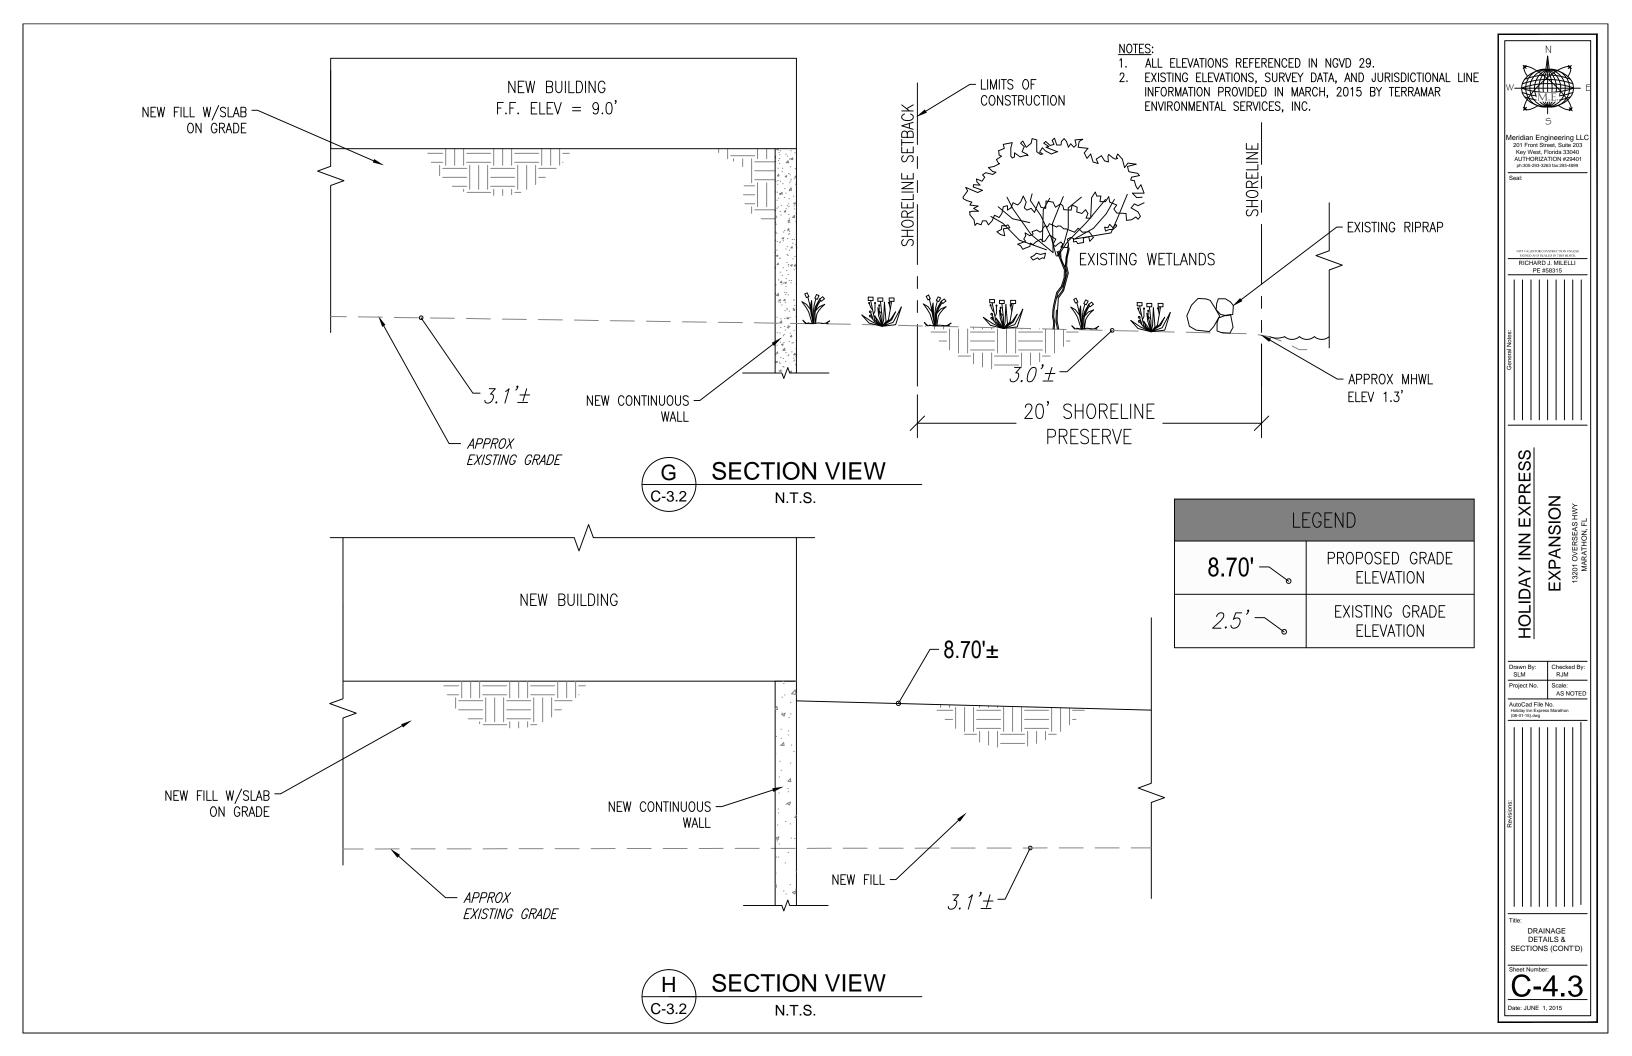



DRAINAGE DETAILS & SECTIONS (CONT'D)


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Date: JUNE 1, 2015



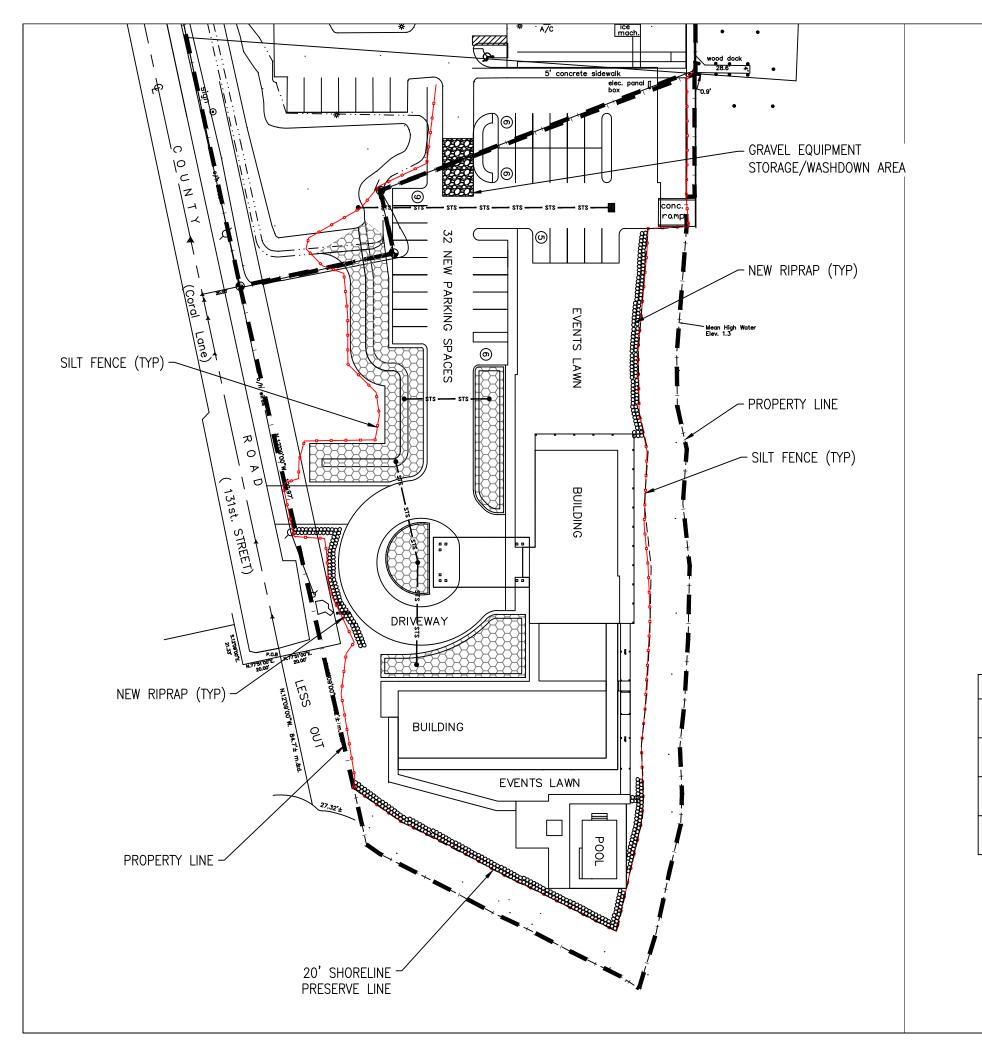

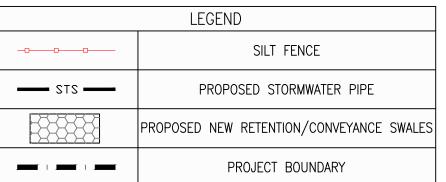


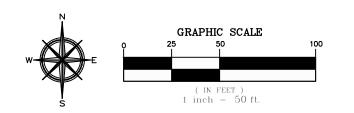

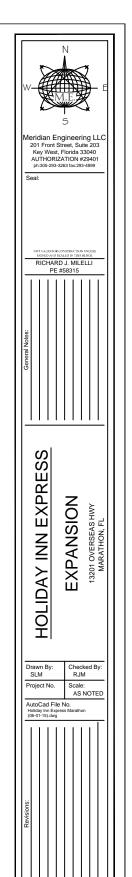EROSION CONTROL PLAN

<u>C-5.0</u>

Date: JUNE 1, 2015

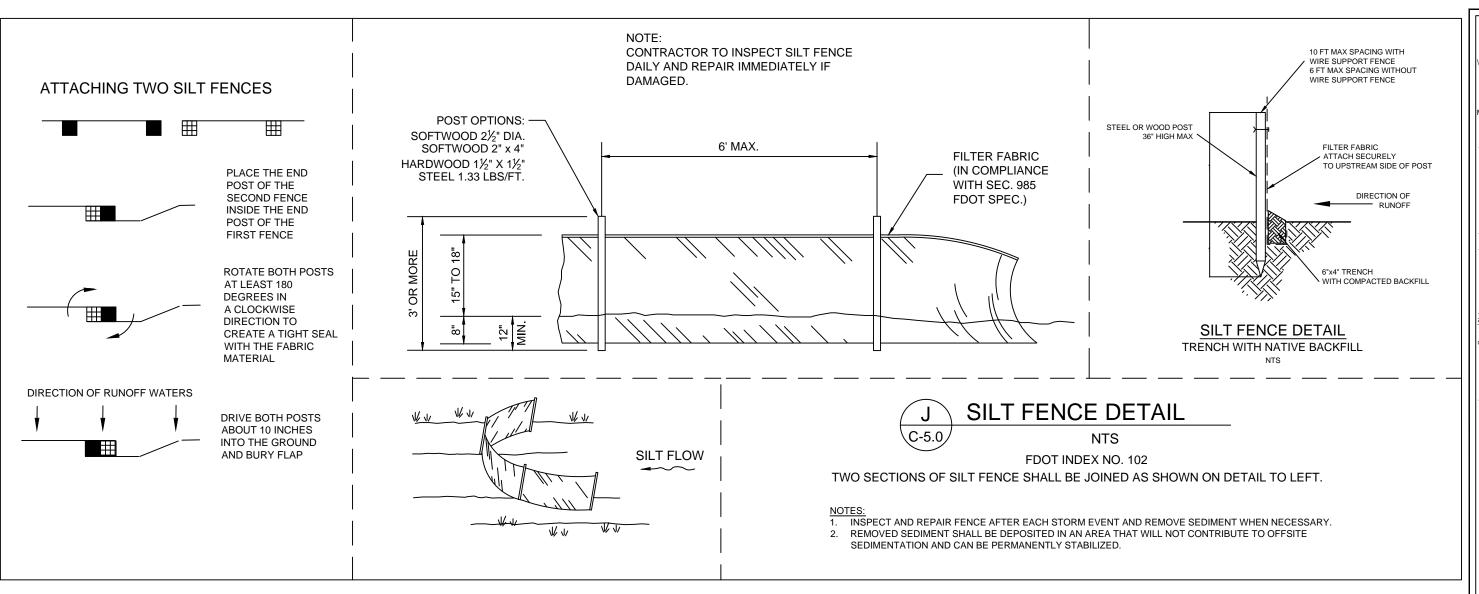

GENERAL NOTES:

- 1. FILTER FABRIC SILT FENCE SHALL BE IN CONFORMANCE WITH SECTION 985, FDOT SPECIFICATION AND INDEX NO. 199.
- 2. CONTRACTOR SHALL INSTALL EROSION CONTROLS NOTED ON DRAWINGS AND APPLICABLE PERMITS, EROSION CONTROLS SHALL BE MAINTAINED UNTIL A PERMANENT STAND OF GRASS IS PLANTED ONSITE.
- 3. SILT FENCE LOCATIONS SHOWN HEREON ARE FOR CLARITY ONLY AND SHOULD BE CONSTRUCTED WITHIN PROPERTY LINES.
- 4. PROVIDE EROSION CONTROL MEASURES CONSISTING OF STAKED SILT FENCES ALONG THE PROPOSED LIMITS OF CONSTRUCTION AS INDICATED ON THE DRAWINGS. PROVIDE ADDITIONAL MEASURES AS NECESSARY TO AVOID ADVERSE IMPACTS TO JURISDICTIONAL AREAS (WETLANDS OR WATER BODIES) AND OFF-SITE LANDS AND WATERBODIES. MAINTAIN THESE MEASURES DAILY UNTIL CONSTRUCTION ACCEPTANCE BY THE OWNER AND THEN REMOVE AND LEGALLY DISPOSE OF SAID MEASURES.
- 5. EROSION CONTROL SHALL BE MAINTAINED WITHIN CONSTRUCTION AREA BY QUICKLY STABILIZING DISTURBED AREA TO PREVENT THE RELEASE OF SEDIMENT. THIS SHALL BE ACCOMPLISHED USING GRASS COVER AND OTHER MEANS ACCEPTABLE TO OWNER, ENGINEER, AND REGULATORY AGENCIES.
- 6. DURING CONSTRUCTION, THE CONTRACTOR SHALL, AT THE REQUEST OF THE OWNER OR AS NECESSARY, MODIFY OR RELOCATE THE ENVIRO—FENCE AND/OR SILT FENCE TO ALLOW FOR ACCESS AND TO COMPLETE CONSTRUCTION. IT IS THE CONTRACTOR'S RESPONSIBILITY TO MAINTAIN ADEQUATE EROSION CONTROL AT ALL TIMES.
- 7. DURING CONSTRUCTION, THE CONTRACTOR SHALL PROVIDE TEMPORARY SEEDING AND MULCHING FOR AREAS THAT HAVE BEEN CLEARED AND NOT REWORKED WITHIN 7 CALENDAR DAYS DURING THE WET SEASON (APRIL THROUGH SEPTEMBER) AND 14 CALENDAR DAYS DURING THE DRY SEASON (OCTOBER THROUGH MARCH). ALSO, ALL SIDE SLOPES SHALL BE SODDED OR SEEDED AND MULCHED WITHIN 7 DAYS DURING WET SEASON AND 14 DAYS DURING THE DRY SEASON.
- 8. ALL SURFACE WATER DISCHARGE FROM SITE, INCLUDING DEWATERING DISCHARGE, SHALL MEET STATE WATER QUALITY STANDARDS PRIOR TO REACHING ANY WATERS OF THE STATE, INCLUDING WETLANDS.
- 9. IN THE EVENT THAT THE EROSION PREVENTION AND CONTROL DEVICES SHOWN IN THESE PLANS PROVE NOT TO BE EFFECTIVE, ALTERNATE METHODS FOR MAINTAINING STATE WATER QUALITY STANDARDS FOR DISCHARGE FROM THE CONSTRUCTION SITE WILL BE REQUIRED. ANY ALTERNATE EROSION PREVENTION AND CONTROL DEVICES MUST BE APPROVED BY THE VILLAGE OF ISLAMORADA AND THE ENGINEER PRIOR TO PLACEMENT.
- 10. CONTRACTOR SHALL BE RESPONSIBLE FOR CONSTRUCTING AND MAINTAINING EROSION CONTROL MEASURES FOR THE DURATION OF THE INFRASTRUCTURE INSTALLATION.



C-5.

Date: JUNE 1, 2015